

City of Austin **BUILDING PERMIT**

PERMIT NO: 2020-113967 BP

Type: RESIDENTIAL

Status: Active

2111 WILSON ST LEGAL DESCRIPTION:

PROPOSED OCCUPANCY:

Issue Date: 10/08/2020

Expiry Date: 04/06/2021

SITE APPROVAL:

ZONING: SF-3-NP

N46.14X115FT BLK 2 DOUGHTY SUBD

WORK PERMITTED:

Addition and Remodel

ISSUED BY:

Aaron Finney

Partial demo Repair/remodel existing detached garage.

TOTAL SQFT	VALUATION	TYPE CONST.	USE CAT	GROUPS	FLOORS	UNITS	# OF PKG SPACES
New/Addn: 0 Remodel : 310	Total Job Valuation : \$1.00 Total Rem : \$.00		434		1	1	2

OF BATHROOMS % COVERAGE METER SIZE TOTAL BLDG COVERAGE % COVERAGE TOTAL IMPERVIOUS COVERAGE 1,428.00 1.0 26.83 2,383.00 44.77 0.00

Contact **Phone** Contact **Phone** Applicant, Paul Bielamowicz (512) 484-3990

General Contractor, Alex Loredo, By Loredo Construction

(512) 799-3717

Internet User, Paul Bielamowicz

(512) 484-3990

Fee Description Fee Amount Paid Date **Building Permit Fee** \$272.15 10/08/2020 Foundation pre-pour tree inspection \$219.00 10/08/2020

Residential Plan Review Fee \$946.00 07/02/2020 Technology Surcharge-DSD

\$22.33 10/08/2020

Total Fees: \$1,642.32 **Fee Description** Fee Amount Paid Date **Demolition Permit Fee** \$67.00 10/08/2020

Residential Plan Review Application \$75.00 07/02/2020

Processing Fee

Technology Surcharge-DSD

\$40.84 07/02/2020

Construction documents approved by the building official are approved with the intent that such construction documents comply in all respects with City technical codes. The review of construction documents is not exhaustive of all code requirements. The issuance or approval of plans and specifications or other construction documents is not an approval of any violation of the technical codes or of any other ordinance of the jurisdiction. The issuance of an approval based on plans, specifications and other data shall not prevent the building official from requiring the correction of errors in the plans, specifications or other data.

The City of Austin has not conducted a plan review of the mechanical, electrical or plumbing on this plan set. Be advised that all work performed on this project must be as per applicable trade code.

Inspection requirements

Building Inspection Electric Inspection

All Buildings, Fences, Landscaping, Patios, Flatwork And Other Uses Or Obstructions Of A Drainage Easement Are Prohibited, Unless Expressly Permitted By A License Agreement Approved By COA Authorizing Use Of The Easement.

UNDE

City Code Chapter 25-12, Article 13: A permit expires on the 181st day if the project has not scheduled nor received an inspection. A "Cancelled" and/or "Failed/No Work Performed" inspection result does not extend the expiration date.

The following permits are required as a separate permit: See Mechanical, Electrical, Plumbing permits for Related Fees and Inspections.

Printed: 10/08/2020 3:04 pm

0-3/20



City of Austin BUILDING PERMIT

PERMIT NO: 2020-113967 BP

Type: RESIDENTIAL

Status: Active

SITE APPROVAL:

2111 WILSON ST

Issue Date: 10/08/2020

Expiry Date: 04/06/2021

000 Bato : 10/00/2020

ZONING: SF-3-NP

LEGAL DESCRIPTION:

PROPOSED OCCUPANCY:

N46.14X115FT BLK 2 DOUGHTY SUBD

WORK PERMITTED:

Addition and Remodel

ISSUED BY:

Aaron Finney

Partial demo Repair/remodel existing detached garage.

TOTAL SQFT	VALUATION	TYPE CONST.	USE CAT	GROUPS	FLOORS	UNITS	# OF PKG SPACES
New/Addn: 0 Remodel : 310	Total Job Valuation : \$1.00 Total Rem : \$.00		434		1	1	2

TOTAL BLDG COVERAGE	% COVERAGE	TOTAL IMPERVIOUS COVERAGE	% COVERAGE	# OF BATHROOMS	METER SIZE
1,428.00	26.83	2,383.00	44.77	1.0	0.00

Comments

Existing detached garage resides in the rear and side setbacks. Project complies with 25-2-963

By Accepting Or Paying For This Permit You are Declaring That You Are The Owner Or Authorized By The Owner That The Data Submitted At The Time Of Application Was True Facts And That The Work Will Conform To The Plans And Specification Submitted Herewith.

Page 2 of 3

To Schedule An Inspection, Call 512-974-9405

Printed: 10/08/2020 3:04 pm

D-3/21



City of Austin BUILDING PERMIT

PERMIT NO: 2020-113967 BP

2111 WILSON ST

Type: RESIDENTIAL Issue Date: 10/08/2020

Status : Active

Expiry Date: 04/06/2021

SITE APPROVAL:

ZONING:

LEGAL DESCRIPTION:

PROPOSED OCCUPANCY:

N46.14X115FT BLK 2 DOUGHTY SUBD

WORK PERMITTED:

Addition and Remodel

ISSUED BY:

Aaron Finney

Printed: 10/08/2020 3:04 pm

SF-3-NP

Partial demo Repair/remodel existing detached garage.

TOTAL SQFT	VALUATION	TYPE CONST.	USE CAT	GROUPS	FLOORS	UNITS	# OF PKG SPACES
New/Addn: 0 Remodel : 310	Total Job Valuation : \$1.00 Total Rem : \$.00		434		1	1	2

<u>Type</u>	<u>Date</u>	<u>Status</u>	<u>Comments</u>	Inspector
100 Bldg Pre-Construction		Open	1	Residential No Inspector
101 Building Layout		Open		Residential No Inspector
102 Foundation	//	Open		Residential No Inspector
103 Framing		Open		Residential No Inspector
104 Insulation		Open		Residential No Inspector
105 Wallboard	1	Open	C 5 (2)	Residential No Inspector
106 Fire Resistance-Rated Const	> .'/	Open		Residential No Inspector
109 TCO Occupancy)	Open		Residential No Inspector
110 Termite Inspection		Open		Residential No Inspector
112 Final Building		Open		Residential No Inspector
114 Continuance of work		Open	8	Residential No Inspector
Deficiencies		Open		Residential No Inspector

EXHIBIT "F"

Plans of Proposed Project
Prepared and signed by a registered
Architect (myself), and "red-stamped"
approved by the City under Building
Permit 2020-113967 BP

BIELAMOWICZ RESIDENCE GARAGE RENOVATION

2111 Wilson Street, Austin, Texas 78704

SHEET INDEX

NUMBER	SHEET NAME	ORIG ISSUE	CURRENT	REV
A-001	PLOT PLAN AND CODE INFORMATION	6/19/2020	6/19/2020	
A-101-A	PHASE "A" DEMOLITION AND FLOOR PLAN	6/19/2020	6/19/2020	
A-101-B	PHASE "B" DEMOLITION AND FLOOR PLAN	6/19/2020	6/19/2020	
A-102	CEILING PLAN AND ROOF PLAN	6/19/2020	6/19/2020	
A-201	EXTERIOR ELEVATIONS	6/19/2020	6/19/2020	
A-301	BUILDING SECTIONS	6/19/2020	6/19/2020	
A-302	WALL SECTIONS	6/19/2020	6/19/2020	
A-501	WINDOW SCHEDULE AND DETAILS	6/19/2020	6/19/2020	
A-502	DOOR SCHEDULE AND DETAILS	6/19/2020	6/19/2020	
A-503	ROOF DETAILS	6/19/2020	6/19/2020	
A-601	FINISH PLAN AND FINISH LEGEND	6/19/2020	6/19/2020	
A-701	ARCHITECTURAL SPECIFICATIONS	6/19/2020	6/19/2020	
A-702	ARCHITECTURAL SPECIFICATIONS	6/19/2020	6/19/2020	
E-101	ELECTRICAL PLAN AND SCHEDULES	6/19/2020	6/19/2020	

6/19/2020

ARCHITECT: PAUL A. BIELAMOWICZ, AIA, LEED AP

2111 Wilson Street, Austin, Texas 78704

(512) 484-3990

Texas Architect Reg. #19917

City of Austin

CODE COMPLIANCE

REVIEWED FOR CODE COMPLIANCE **ISSUED FOR CONSTRUCTION - JUNE 19, 2020**

ZONING INFORMATION ZONING USE DESIGNATION: SF-3 NP NOTES ON EXISTING NON-CONFORMANCE: MIN. LOT SIZE: 5.750 SF - LOT IS AN EXISTING NON-CONFORMING MIN. LOT WIDTH: LOT, (WIDTH <50') PLATTED PRIOR TO 1946. 50' MAX. HEIGHT: - HOUSE IS AN EXISTING NON-CONFORMING 35' MINIMUM SETBACKS: STRUCTURE (SIDE-YARD SETBACK), BUILT 25' IN 1930. THE HOUSE IS NOT PART OF THIS FRONT YARD: STREET SIDE YARD: 15' PROJECT. 5' - GARAGE IS AN EXISTING NON-INTERIOR SIDE YARD: REAR YARD: 10' CONFORMING STRUCTURE (SIDE YARD - ACCESSORY STRUCTURES 5' AND REAR SETBACKS), BUILT IN 1930. MAXIMUM BUILDING COVERAGE: 40 % MAXIMUM IMPERVIOUS COVER: SITE AREAS TOTAL SITE AREA: 5,323 SF IMPERVIOUS COVER 1.092 SF HOUSE **STRUCTURES** GARAGE 310 SF 1,092 SF FRONT PORCH **EXISTING HOUSE:** 26 SF GARAGE: 310 SF **DRIVEWAY** 705 SF BACK DECK (@50%) PORCH: 26 SF 106 SF FRONT WALKWAY 136 SF ALLOWED BLDG COVERAGE: 40% A/C PAD 8 SF BUILDING COVERAGE: 26.8% IMPERVIOUS AREA 2.383 SF ALLOWED IMPERVIOUS %: 45% ACTUAL IMPERVIOUS %: - DECK IS COUNTED AT 50% PERVIOUS 44.8%



REVISION HISTORY

REGULATORY INFORMATION JURISDICTION: LOCAL CODES: CITY OF AUSTIN, TX CITY OF AUSTIN - LAND DEVELOPMENT CODE 2015 INT'L BUILDING CODE (IBC) w/ LOCAL AMENDMENTS 2015 INT'L ENERGY CODE w/ LOCAL AMENDMENTS 2015 INT'L FIRE CODE w/ LOCAL AMENDMENTS 8" FIG 2015 INT'L RESIDENTIAL CODE (IRC) w/ LOCAL AMENDMENTS 2015 UNIFORM MECHANICAL CODE W/ LOCAL AMENDMENTS 2015 UNIFORM PLUMBING CODE w/ LOCAL AMENDMENTS 2017 NATIONAL ELECTRICAL CODE w/ LOCAL AMENDMENTS GAS METER **BOULDIN CREEK NEIGHBORHOOD PLAN** 12" FIG 8 MONTERREY OAK EXISTING MAIN ELEC PANEL 12" PECAN EXISTING EXISTING EXISTING DRIVEWAY TO REMAIN GARAGE EXISTING STRUCTURE EXISTING City of Austin REVIEWED FOR CODE COMPLIANCE OVERALL SITE PLAN

ORIG. ISSUE DATE: 2020-06-19 SCALE: 1/16" = 1'-0" DRAWN BY: PAB FILE NAME: 2018-01-A001.dwg

PAUL BIELAMOWICZ, AIA, LEED AP
2111 Wilson Street
Austin, Texas 78704

(512) 484-3990


KLVISI	REVISION HISTORY								
REV.	DESCRIPTION	DATE							
·									
·									


GARAGE RENOVATION


Bielamowicz Residence 2111 Wilson Street Austin, Texas 78704





PLOT PLAN AND CODE INFORMATION

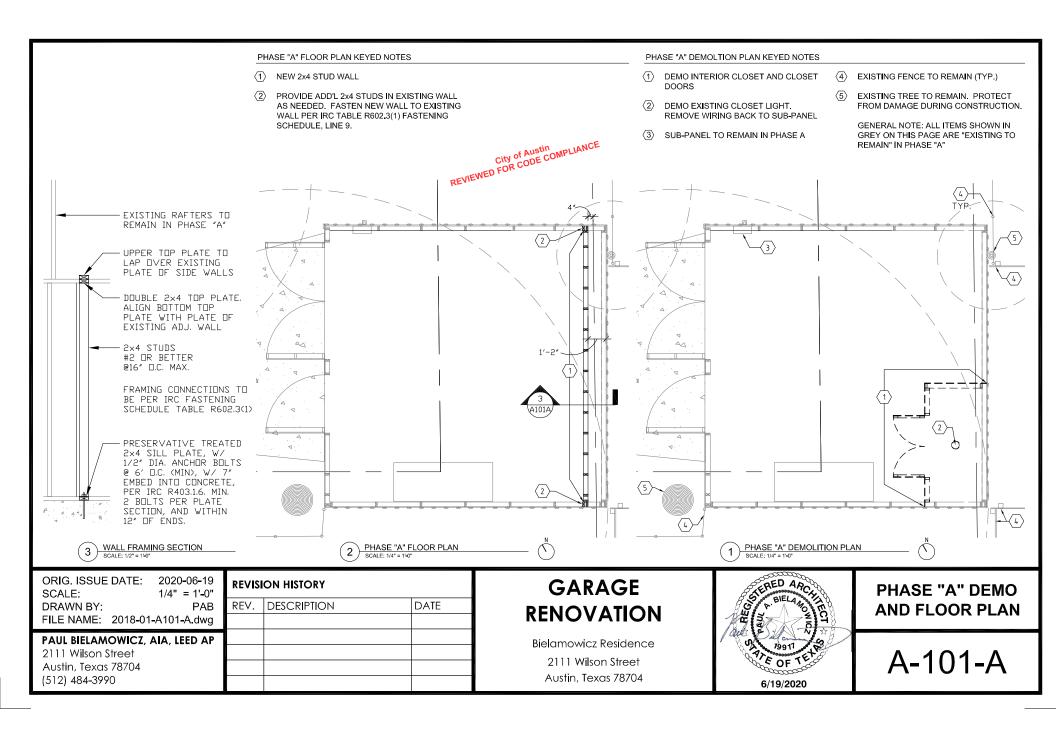


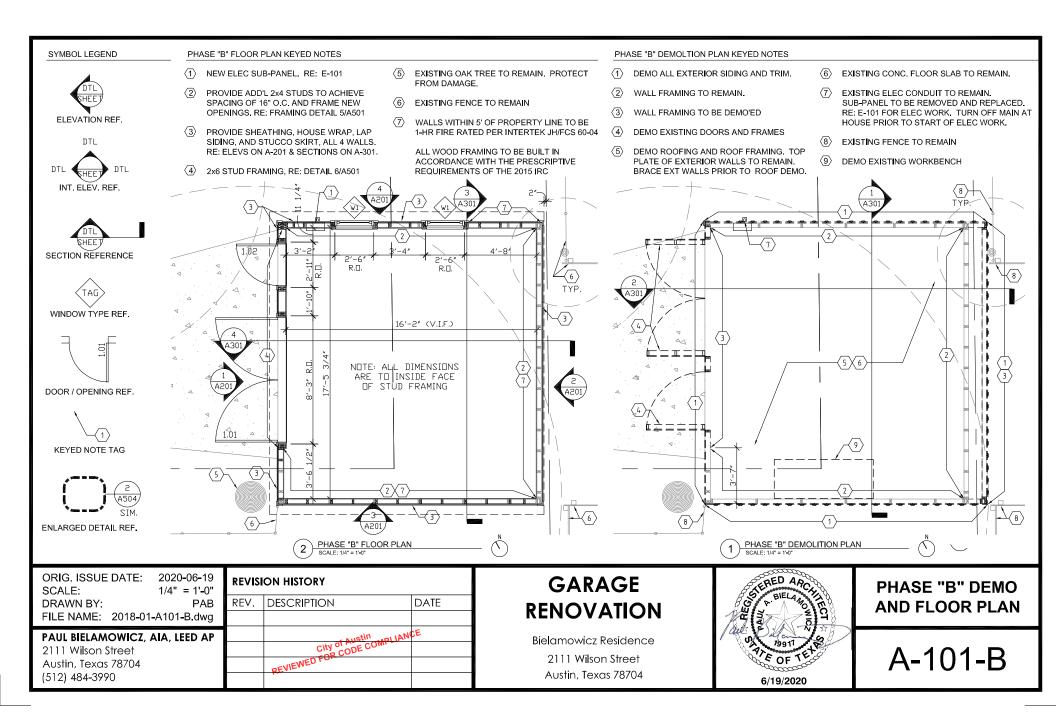

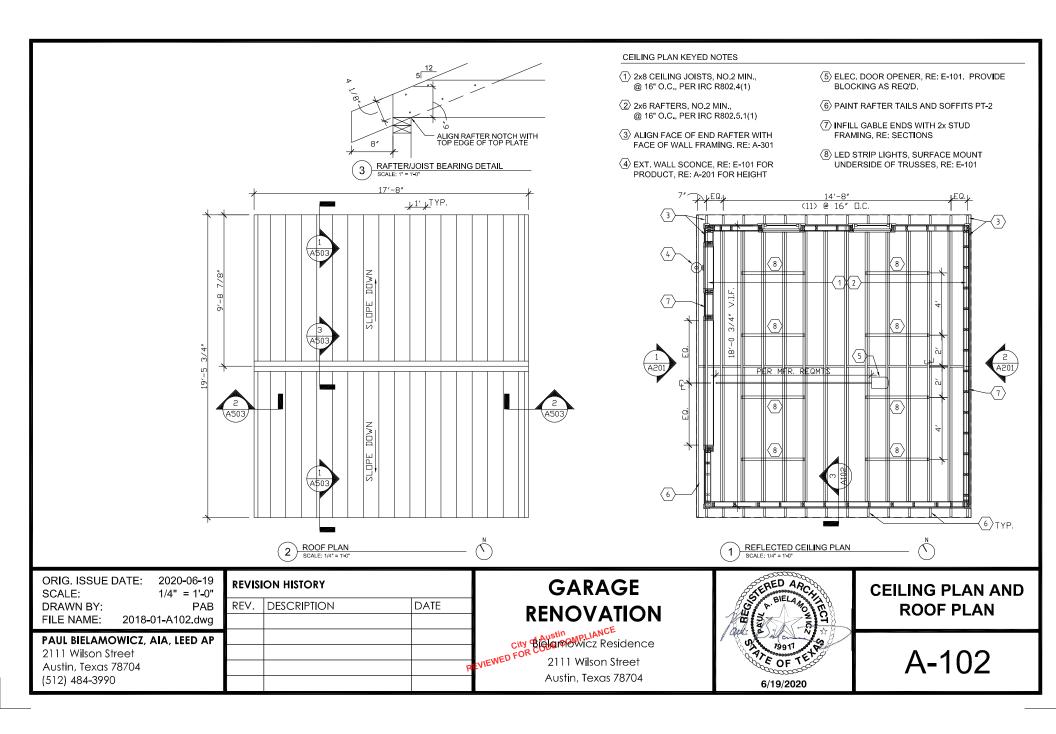

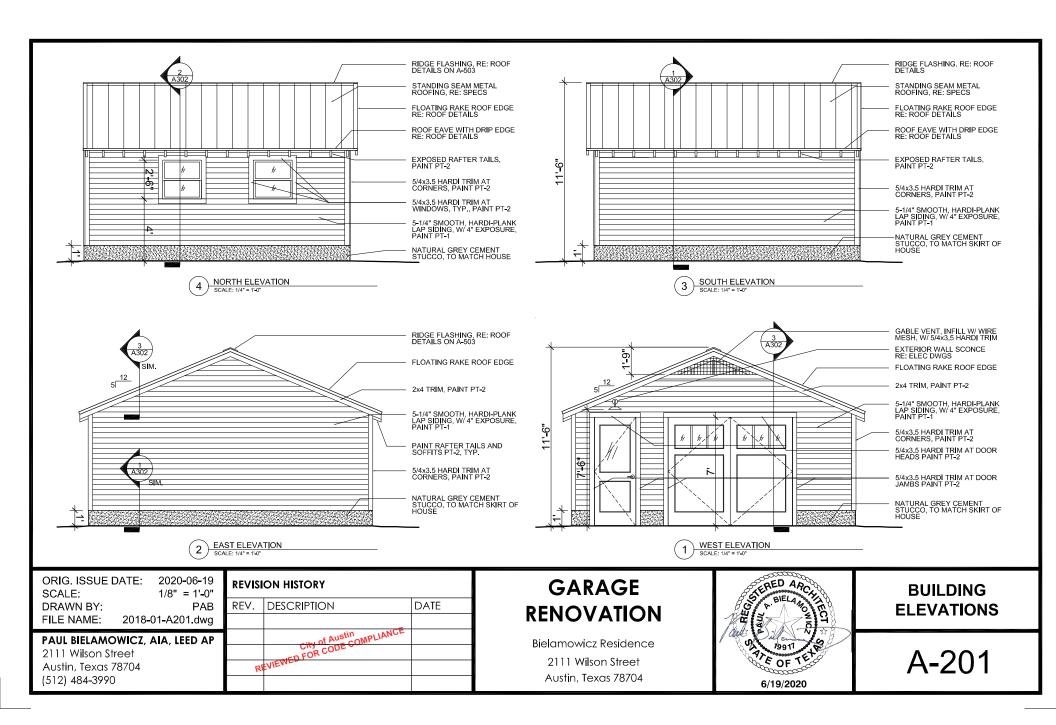

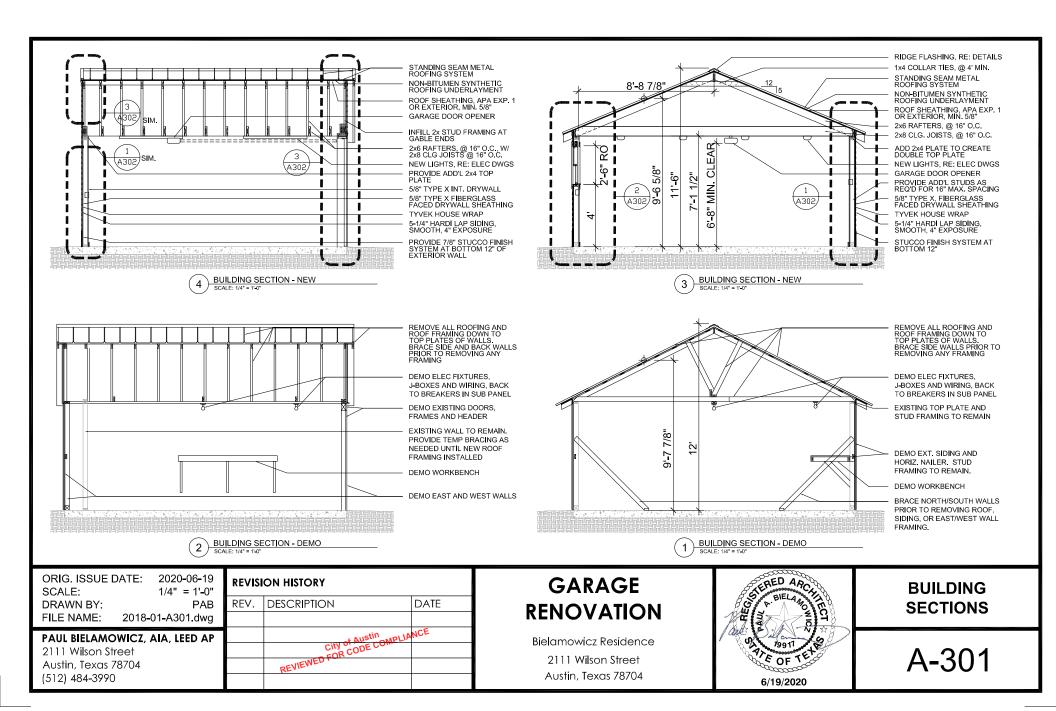

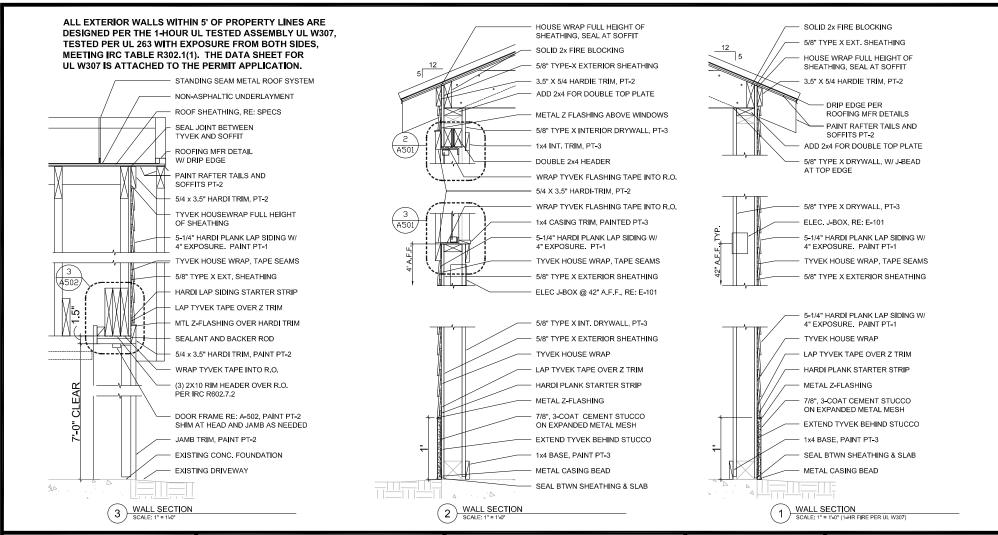


ORIG. ISSUE DATE: 2020-06-19 **REVISION HISTORY** SCALE: 1" = 1'-0" REV. DESCRIPTION DATE PAB DRAWN BY: FILE NAME: 2018-01-A302.dwg City of Austin
City of Austin
REVIEWED FOR CODE COMPLIANCE PAUL BIELAMOWICZ, AIA, LEED AP 2111 Wilson Street Austin, Texas 78704 (512) 484-3990

GARAGE RENOVATION

Bielamowicz Residence 2111 Wilson Street Austin, Texas 78704



WALL SECTIONS

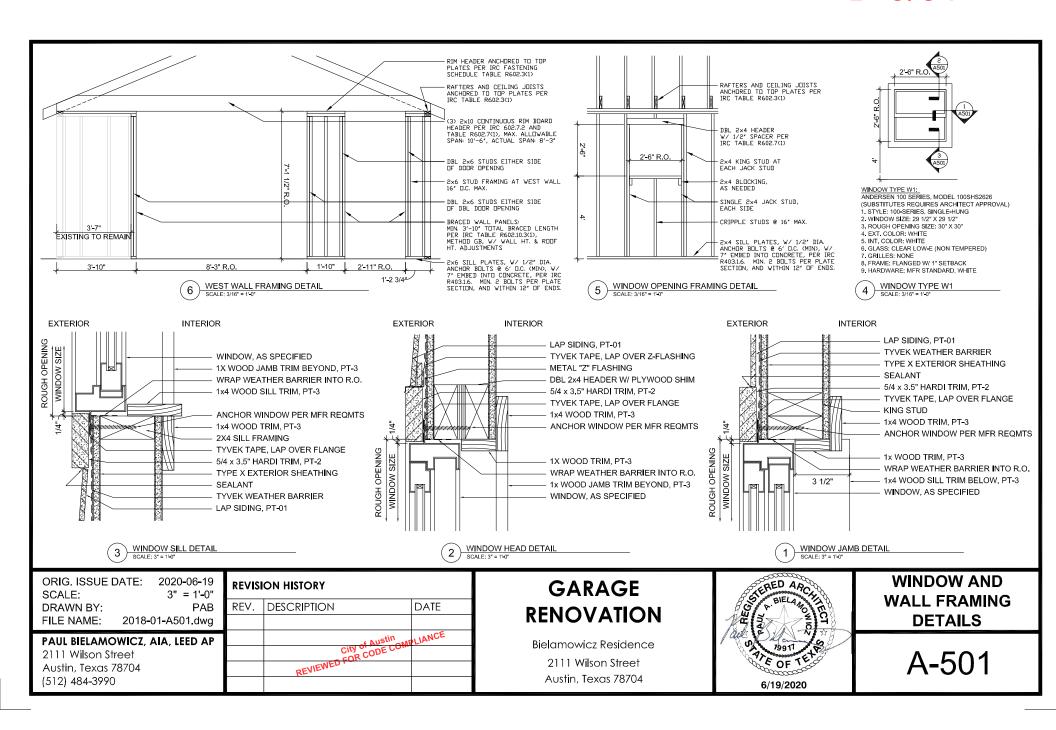

B' 3'

Α

В

DOOR SCHEDULE, HARDWARE SETS, AND NOTES

DOOR	R DOOR FRAME							HDWR.	FIRE			
NO.	TYPE	WIDTH	HEIGHT	THICK.	MATL.	MATL.	HEAD	JAMB	JAMB	SILL	SET	LABEL
1.01	Α	8'-0" PR	7'-0"	1-3/4"	WD	WD	3/A502	2/A502	2/A502 (SIM)	1/A502	HW-1	N/A
1.02	В	3'-0"	7'-0"	1-3/4"	WD	WD	3/A502	2/A502	2/A502 (SIM)	1/A502	HW-2	N/A

HARDWARE SET #1 - OUTSWING CARRAIGE DOORS


QTY.	ITEM	MFR.	MODEL	FINISH	NOTES
8	HINGES	PBB	4B51-NRP	US32D	4.5"x4", SQUARE CORNERS
2	BOTTOM SEAL	PEMKO	313AN	GREY	FULLY MORTISED, 48"
1	WEATHERSTRIP	PEMKO	P-50W	WHITE	HEAD AND JAMBS
1	WEATHERSTRIP	PEMKO			ASTRAGAL
2	FLUSH BOLTS	HAGER	275D	S.S.	MOUNT AT HEAD


HARDWARE SET #2 - EXTERIOR ENTRANCE DOOR


QTY.	ITEM	MFR.	MODEL	FINISH	NOTES
1	EXT. HANDLESET	KWIKSET	800SE	15	SHELBURNE, SATIN NICKLE
1	INT. TRIM	KWIKSET	966TNL	15	TUST I N, SATIN NICKLE
4	HINGES	PBB	BB51-NRP	US32D	4"x4", SQUARE CORNERS
1	BOTTOM SEAL	PEMKO	313AN	GREY	FULLY MORTISED, 36"
1	WEATHERSTRIP	PEMKO	P-50W	WHITE	HEAD AND JAMBS
1	KICKPLATE	ROCKWOOD	K1050	630 SS	8"X34", SATIN STAINLESS STL

DOOR SPECIFICATION NOTES

- 1. DOOR TYPE "A" TO BE PAIR OF DOORS, EACH LEAF TO BE SIMPSON #6813, 1-3/4" THICK EXT. GRADE WOOD DOORS, SINGLE PANEL/THREE LITE W/ CLEAR 3/4" INSULATED GLASS (TDL), SQUARE STICKING, IN STAIN GRADE DOUGLAS FIR. EQUAL DOORS BY OTHER MANUFACTURERS ACCEPTABLE WITH ARCHITECTS APPROVAL
- 2. DOOR TYPE "B" TO BE SIMPSON #7081, 1-3/4" THICK EXT. GRADE WOOD DOOR, HALF-LITE W CLEAR 3/4" INSULATED GLASS, SQUARE STICKING, IN STAIN GRADE DOUGLAS FIR. EQUAL DOORS BY OTHER MANUFACTURERS ACCEPTABLE WITH ARCHITECTS APPROVAL
- 3. WOOD DOOR FINISH TO BE AS FOLLOWS:
- ONE COAT WOOD CONDITIONER
- ONE COAT MINWAX ENGLISH CHESTNUT STAIN
- 3-COATS MINWAX CLEAR SATIN SPAR URETHANE, LIGHT SANDING BETWEEN EACH COAT

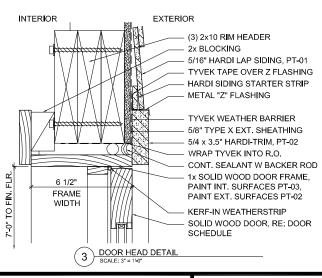

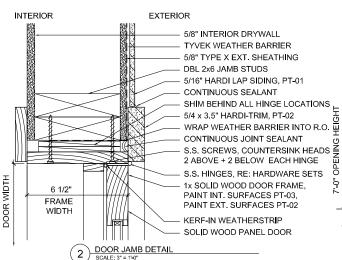

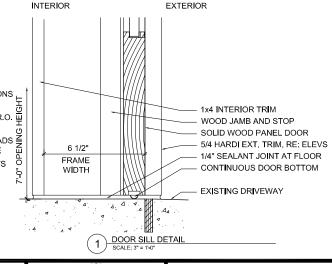

ORIG. ISSUE D SCALE:	ATE: 2020-06-19 3" = 1'-0"	RI
DRAWN BY:	PAB	RE
FILE NAME:	2018-01-A502.dwg	
PAUL BIELAMON	WICZ, AIA, LEED AP	
2111 Wilson Str	eet	

PAUL BIELAMOWICZ, AIA, LEED AP	
2111 Wilson Street	
Austin, Texas 78704	
(512) 484-3990	

REVISION HISTORY						
REV.	DESCRIPTION	DATE				
	city of Austin	ANCE				
	City of Austin City of Austin CODE COMPL REVIEWED FOR CODE COMPL					
	REVIEWED					

GARAGE RENOVATION

Bielamowicz Residence 2111 Wilson Street Austin, Texas 78704



DOOR SCHEDULE AND DETAILS


NOTE: DETAILS ON THIS PAGE ARE TAKEN FROM THE INSTALLATION INSTRUCTIONS FOR THE PROSNAP 100 ROOFING SYSTEM BY CENTRAL TEXAS METAL ROOFING SUPPLY CO., INC. FASTENER #14 (POP RIVET) 4" O.C. OR FASTENER # 4 (¼"-14 X %" LAP) OR #7 (¼"-14 X %" LONG LIFE) 20" O.C. SEALANT RIDGE FLASHING PROSNAP 100 PANEL UNDERLAYMENT BY OTHERS FASTENER # 12 (10-12 x 1" PANCAKE) 6" O.C. SUBSTRUCTURE -(10-12 x 1" PANCAKE) 18" O.C. RIDGE DETAIL SCALE; 6" = 1'-0" FASTENER #14 (POP RIVET) TAPE SEALER PROSNAP 100 PANEL 6" O.C. OR PLACE FIRST FASTENER 6" FASTENER # 4 (1/4"-14 X 7/8" LAP) FROM EAVE, THEN FOLLOW BOX RAKE OR #7 (14"-14 X 78" LONG LIFE) 20" O.C. **USE SEALANT AT** ALL PANEL ENDS FIELD TURN PANEL UP 1" UNDERLAYMENT FASTENER # 12 (10-12 X 1" PANCAKE) FASTENER # 12 (10-12 X 1" PANCAKE) SUBSTRUCTURE 20" O.C. FASTENER # 12 (10-12 X 1" PANCAKE) City of Austin
REVIEWED FOR CODE COMPLIANCE FASTENER # 12 (10-12 X 1" PANCAKE) CONTINUOUS 20" O.C. TAPE SEALER UNDERLAYMENT TYPICAL FIXED RAKE EDGE DETAIL TYPICAL EAVE DETAIL ORIG. ISSUE DATE: 2020-06-19 **GARAGE REVISION HISTORY ROOF** SCALE: 6" = 1'-0" REV. DESCRIPTION DATE DRAWN BY: PAB **DETAILS RENOVATION** FILE NAME: 2018-01-A503.dwg PAUL BIELAMOWICZ, AIA, LEED AP Bielamowicz Residence 2111 Wilson Street ATE OF T A-503 2111 Wilson Street Austin, Texas 78704 Austin, Texas 78704 (512) 484-3990 6/19/2020

	FINISH LEGEND					
TAG	MATERIAL	MANUFACTURER	SERIES	COLOR / NUMBER	COMMENTS	
PT-01	EXT. LATEX PAINT	SHERWIN WILLIAMS	DURATION SERIES / FLAT	RYEGRASS / SW 6423	EXTERIOR SIDING	
PT-02	EXT. LATEX PAINT	SHERWIN WILLIAMS	DURATION SERIES / SATIN	DOVER WHITE / SW 6385	EXTERIOR TRIM	
PT-03	INT. LATEX PAINT	SHERWIN WILLIAMS	HARMONY SERIES / EG SHEL	DOVER WHITE / SW 6385	INTERIOR WALLS & TRIM	
WD-01	STAINED WOOD	MINWAX	HELMSMAN SPAR URETHANE	CLEAR SATIN DVER ENGLISH CHESTNUT STAIN	WOOD DOORS (RE: DOOR NOTES)	

FINISH PLAN GENERAL NOTES

- 1 NO APPLIED FLOOR FINISH OVER EXISTING CONCRETE FLOOR
- 2 NO APPLIED CEILING FINISH. ROOF FRAMING AND UNDERSIDE OF ROOF DECKING TO BE EXPOSED TO VIEW
- 3 ALL BASE AND CASING TRIM TO BE PAINT GRADE WOOD 1x4, POPLAR OR PINE
- 4 PROVIDE INTERIOR DRYWALL UP TO TOP PLATE OF ALL WALLS. PROVIDE CASING BEAD AT TOP EDGE OF DRYWALL.

PROVIDE 1x4 WOOD BASE, TYP., PAINTED PT-3. REFER TO A-501 & A-502 FOR WINDOW AND DOOR TRIM

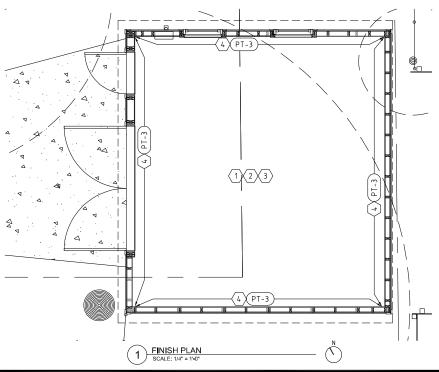

City of Austin REVIEWED FOR CODE COMPLIANCE

ORIG. ISSUE DATE: 2020-06-19 SCALE: 1/4" = 1'-0"	REVISION HISTORY			
DRAWN BY: PAB	REV.	DESCRIPTION	DATE	
FILE NAME: 2018-01-A601.dwg				
PAUL BIELAMOWICZ, AIA, LEED AP				
2111 Wilson Street				
Austin, Texas 78704				
(512) 484-3990				

GARAGE RENOVATION

Bielamowicz Residence 2111 Wilson Street Austin, Texas 78704



FINISH PLAN AND FINISH LEGEND

PROJECT SPECIFICATIONS

DIVISION 1 - GENERAL REQUIREMENTS

- 1. CODES: ALL WORK SHALL COMPLY WITH THE TECHNICAL CODES ADOPTED BY THE CITY OF AUSTIN, INCLUDING LOCAL AMENDMENTS.
- 2. NO SUBSTITUTIONS WITHOUT WRITTEN APPROVAL OF ARCHITECT.

DIVISION 2 - SITEWORK

- 1. PROVIDE TREE PROTECTION AS REQUIRED BY CITY OF AUSTIN
- 2. CONTRACTOR SHALL BE RESPONSIBLE FOR REMOVAL AND APPROPRIATE DISPOSAL OF ALL DEMOLISHED MATERIALS

DIVISION 3 - CONCRETE

NOT USED

DIVISION 6 - WOOD AND PLASTICS

06100 ROUGH CARPENTRY

- 1. FRAMING MEMBERS TO BE MIN. NO. 2 GRADE, SYP., S4S
- 2. USE MOISTURE RESISTANT. PRESERVATIVE TREATED WHERE INDICATED, YELLA WOOD OR EQUAL
- 3. PROVIDE 2x BLOCKING AS NEEDED AT CEILING AND WALL HUNG FIXTURES AND DEVICES

06160 SHEATHING

- 1. EXTERIOR WALL SHEATHING SHALL BE 5/8", TYPE-X, GLASS-MAT FACED, AS LISTED IN UL DESIGN NO. W307 City of Austin REVIEWED FOR CODE COMPLIANCE **ACCEPTABLE MANUFACTURERS:**
 - CERTAINTEED GYPSUM
 - AMERICAN GYPSUM
 - GEORGIA PACIFIC
 - NATIONAL GYPSUM
 - USG
- 2. ROOF DECKING SHALL BE 5/8" CDX EXTERIOR GRADE PLYWOOD NO ADDED UREA FORMALDEHYDE

06200 FINISH CARPENTRY

1. INT. BASE AND CASING TRIM TO BE PAINT GRADE WOOD 1X4. PINE OR POPLAR

DIVISION 7 - THERMAL AND MOISTURE PROTECTION

07270 WEATHER BARRIERS

- 1. WEATHER BARRIER TO BE DUPONT TYVEK HOMEWRAP
- MECH, FASTEN PER MFR'S INSTRUCTIONS, TAPE ALL SEAMS
- 2. TAPE/FLASHING IS TO BE DUPONT TYVEK FLEX WRAP
- WRAP SILLS, JAMBS AND HEADS OF ALL ROUGH OPENINGS
- 3. METAL FLASHINGS AND DRIP EDGES TO BE GALVANIZED OR STAINLESS STEEL, MINIMUM 25 GAUGE.
- INSTALL METAL Z-FLASHING AT HEADS OF ALL EXT. WINDOWS AND DOORS, AND AT TRANSITION BETWEEN SIDING AND STUCCO SKIRT

07310 ROOFING

- 1. STANDING SEAM METAL ROOFING
- PROVIDE PRO-SNAP 100 BY CENTRAL TEXAS METAL ROOFING SUPPLY, OR ARCHITECT APPROVED EQUAL
- 12" WIDE, 24 GA, PANELS
- FINISH: KYNAR 500 PVDF RESIN W/ 30-YR WARRANTY
- COLOR: STONE WHITE
- PROVIDE CONTINUOUS DRIP EDGES, AND SEALED RIDGE
- 2. UNDERLAYMENT, #30 NON-BITUMEN SYNTHETIC, PER ASTM D226, TYPE 2

07460 CEMENT BOARD LAP SIDING

- 1, CEMENT BOARD SIDING TO BE HARDI-PLANK LAP SIDING
- SMOOTH SURFACE (NO TEXTURE)
- 5/16" THICK, 5-1/4" (4" EXPOSURE)
- FACTORY PRIMED. FIELD APPLY PRIMER ON ANY FIELD CUTS
- BLIND NAIL. WITH STARTER STRIPS AT FIRST PLANK
- PROVIDE METAL FLASHING AT BUTT SEAMS BETWEEN BOARDS
- INSTALL PER MFR'S HZ-10 INSTALLATION INSTRUCTIONS
- 2. EXTERIOR TRIM BOARDS TO BE HARDI-TRIM CEMENT BOARD
- NOMINAL 5/4" SIZES AS PER DRAWINGS
- FACTORY PRIMED. FIELD APPLY PRIMER ON ANY FIELD CUTS
- INSTALL PER MFR'S HZ-10 INSTALLATION INSTRUCTIONS

ORIG. ISSUE DATE: 2020-06-19 **REVISION HISTORY** N.T.S. SCALE: REV. DESCRIPTION DATE PAB DRAWN BY: FILE NAME: 2018-01-A701.dwg PAUL BIELAMOWICZ, AIA, LEED AP 2111 Wilson Street Austin, Texas 78704 (512) 484-3990

GARAGE **RENOVATION**

Bielamowicz Residence 2111 Wilson Street Austin, Texas 78704



PROJECT SPECIFICATIONS

DIVISION 7 - THERMAL AND MOISTURE PROTECTION (CONTINUED)

07900 JOINT SEALANTS

1. EXTERIOR CAULK/SEALANT: DAP "ALEX PLUS" ALL PURPOSE SILICON LATEX SEALANT, WHITE COLOR, PAINTABLE

DIVISION 8 - DOORS AND WINDOWS

08210 WOOD STILE AND RAIL PANEL DOORS

- 1. EXTERIOR WOOD STILE AND RAIL PANEL DOORS
- SIMPSON DOORS: STYLE AND SIZES AS NOTED IN DWGS
- DOOR THICKNESS: 1-3/4"
- FLAT PANELS WITH SQUARE STICKING (SHAKER STYLE)
- GLAZING TO BE INSULATED GLASS, MIN. 5/8" THICKNESS
- PREFINISHED, WITH MANUFACTURER'S FINISH WARRANTY
- REFER TO A-502 FOR SIZES, PANEL DESIGN, AND FINISH

08590 WINDOWS

1. ANDERSEN WINDOWS, 100 SERIES, MODEL 100SHS2626, RE: A-501

08700 DOOR HARDWARE

1. REFER TO HARDWARE SETS AS SPECIFIED ON SHEET A-502

DIVISION 9 - FINISHES

09200 CEMENT PLASTER STUCCO

- 1. INTENT IS TO MATCH STUCCO SKIRT OF THE HOUSE
- 2. PROVIDE PORTLAND CEMENT BASED, FACTORY PRE-MIXED, PRE-SANDED, ACRYLIC FIBER REINFORCED PLASTER STUCCO
- 3. INSTALL USING 3 COATS:
- SCRATCH COAT MIN, 3/8", FULLY BED IN METAL LATH
- BROWN COAT MIN, 3/8" THICK
- FINISH COAT MIN. 1/8" THICK
- 4. FINISH TO BE SMOOTH TROWEL FINISH
- 5. COLOR IS TO MATCH EXISTING GREY CEMENT COLOR ON HOUSE
- 6. METAL LATH TO BE GALVANIZED DIAMOND MESH MIN. WEIGHT OF 3.4 LB PER SQ. YD.

DIVISION 9 - FINISHES (CONTINUED)

09250 INTERIOR DRYWALL

- 1. ACCEPTABLE MANUFACTURERS:
- CERTAINTEED GYPSUM
- AMERICAN GYPSUM
- GEORGIA PACIFIC
- NATIONAL GYPSUM
- USG
- 2. 5/8" THICK, TYPE-X DRYWALL PANELS, W/ TAPERED EDGES, AS LISTED IN UL DESIGN NO. W307
- USE TYPE W, 1-1/4" BUGLE-HEAD SCREWS, MIN. 8" O.C.
- TAPE AND FLOAT ALL JOINTS AND SCREW HOLES
- PROVIDE METAL CORNER BEADS AT ALL OUTSIDE CORNERS
- ALL PAINTED SURFACES TO BE TAPED & FLOATED TO SMOOTH LEVEL 4 FINISH, NO TEXTURE

09910 PAINT

- 1. EXTERIOR PAINT
- SHERWIN WILLIAMS DURATION EXTERIOR ACRYLIC LATEX
- COLOR AND SHEEN PER FINISH SCHEDULE ON A-601
- MIN. TWO FINISH COATS OVER PRIMED SURFACES
- 2. INTERIOR PAINT
- SHERWIN WILLIAMS HARMONY ZERO-VOC ACRYLIC LATEX
- COLOR AND SHEEN PER FINISH SCHEDULE ON A-601
- ONE COAT HARMONY LATEX PRIMER, W/ MIN. 2 FINISH COATS

09930 WOOD STAIN (FOR EXTERIOR WOOD DOORS)

- INTENT IS FOR GARAGE DOORS TO MATCH DOORS ON HOUSE
- STAIN: MINWAX OIL-BASED STAIN, COLOR: ENGLISH CHESTNUT
- EXTERIOR PROTECTIVE FINISH: MINWAX CLEAR SATIN SPAR-URETHANE, 3-COATS, SANDING BETWEEN COATS



ORIG. ISSUE DATE: 2020-06-19 SCALE: N.T.S. DRAWN BY: PAB FILE NAME: 2018-01-A702.dwg PAUL BIELAMOWICZ, AIA, LEED AP 2111 Wilson Street Austin, Texas 78704 (512) 484-3990 REVISION HISTORY REV. DESCRIPTION DATE REV. DESCRIPTION (512) 484-3990

GARAGE RENOVATION

Bielamowicz Residence 2111 Wilson Street Austin, Texas 78704



PROJECT SPECIFICATIONS

SYMBOL LEGEND

GFC| RECEPTACLE

⊕ CT_GECLBEC

EXT. GFCI RECEPTACLE W/ WEATHERPROOF BOX

SWITCH

WALL MOUNTED LIGHT

LED STRIP UTILITY LIGHT

S

CEILING MOUNTED SMOKE DETECTOR

	ELECTRICAL FIXTURE SCHEDULE						
TAG	DESCRIPTION	MFR	MODEL	TRIM/ COLOR	COMMENTS		
LT01	STRIP LED UTILITY LIGHT	LITHONIA	MNSL L48 2LL MVOLT GZN 40K 80CRI M6	WHITE	120V, 50 WATT		
LT02	OUTDOOR WALL SCONCE	Y DECOR	LORA 1-LIGHT EL0523SG	SILVER TONE	120V		
DR01	AUTOMATIC Door opener	FREEMONT	AOCM W PUSH RODS, 3/4 HP	N/A	120V AC (RE: REAL CARRAIGE DOOR CO.)		
EV01	ELEC VEHICLE CHARGE STATION	TESLA	TESLA WALL CONNECTOR	SILVER	240V AC 8.5′ CABLE		

PANEL "B" GARAGE SUB-PANEL - 100					
	#	AMPS	VOLTAGE	USE / DESCRIPTION	
	B.1	60	240	TESLA WALL CONNECTOR	
	B.2	В	240	VEHICLE CHARGER	
	B.3	20	120	TABLE SAW RECEPTACLE	
	B.4	20	120	GENERAL RECEPTACLES	
	B.5	20	120	AUTOMATIC DOOR OPENER	
	B.6	20	120	INTERIOR LIGHTS	
	B.7	20	120	EXTERIOR LIGHTS	
	B.8	20	120	SPARE	


City of Austin
City of Austin
REVIEWED FOR CODE COMPLIANCE

ELECTRICAL GENERAL NOTES

- ELECTRICAL WORK TO BE PERFORMED BY A LICENSED ELECTRICIAN, AND SHALL MEET ADOPTED CODES
- ALL DEVICES SHALL BE LISTED AND LABELED, IN ACCORDANCE WITH IRC E3403.3
- ALL CONDUCTORS SHALL BE COPPER, SIZED TO MEET IRC TABLE E3705.1 FOR AMPACITIES SHOWN
- ALL RECEPTACLES SHALL BE GFCI RECEPTACLES.
- ALL CIRCUITS TO BE PROPERLY LABELED IN PANEL BOXES.
- ELECTRICAL BOXES RECESSED INTO MEMBRANES OF FIRE-RATED PORTIONS OF EXTERIOR WALLS TO BE STEEL BOXES, LIMITED TO 16 SQ. INCHES EACH, AND NO MORE THAN 100 SQ. INCHES IN ANY 100 SF OF WALL. APPROPRIATELY SEPARATED. MEETING THE REQUIREMENTS OF IRC R302.4.2 EXCEPTION 1.

ELECTRICAL PLAN KEYED NOTES

- (1) INSTALL NEW SUB-PANEL (PANEL B) 100-AMP, 20-SPACE, RECESSED PANEL
- 2 TESLA CHARGER (O.F.C.I.)
- (3) CONFIRM CONDUCTOR SIZE BETWEEN HOUSE AND NEW GARAGE PANEL "B". UPGRADE CONDUCTOR AS REQ'D. RE: A-001 FOR MAIN PANEL LOCATION
- (4) CENTER GFCI RECEPTACLES 42" A.F.F.
- (5) MAIN BREAKER IN MAIN PANEL AT HOUSE TO BE UPGRADED TO 200-AMP. RE: A-001 FOR MAIN PANEL LOCATION
- UPGRADE BREAKER IN MAIN PANEL FEEDING GARAGE TO 100-AMP BREAKER RE: A-001 FOR MAIN PANEL LOCATION

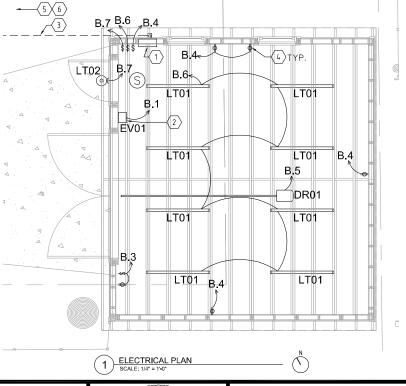

ORIG. ISSUE DATE: 2020-06-19 SCALE: 1/4" = 1'-0" DRAWN BY: PAB

FILE NAME: 2018-01-E101.dwg

PAUL BIELAMOWICZ, AIA, LEED AP

2111 Wilson Street Austin, Texas 78704 (512) 484-3990

REVISION HISTORY					
REV.	DESCRIPTION	DATE			

GARAGE RENOVATION

Bielamowicz Residence 2111 Wilson Street Austin, Texas 78704



ELECTRICAL PLAN AND SCHEDULES

E-101

EXHIBIT "G"

Photos of Work Completed under Building Permit 2020-113967 BP, showing the garage in relation to the Heritage Oak Tree and Pecan Tree.

(all work was stopped after notification was sent on 10/26/2020)